


1. There should not be any court case or any completion from any corner in respect of the building plan No. 59/28 (Reg. No.) Subject to the completion of work by the applicant to this end are:-


- The construction of work should conform to the provisions of the Indian Building Code of Practice and all the conditions as proposed in the plan should be fulfilled.
- All building materials necessary for construction should conform to standard specified in the B.C. of India.
- Necessary steps should be taken for safety of lives of the adjoining public and private property during construction.
- Construction site should be maintained to prevent mosquito breeding.
- Design of all structural members including that of the foundation should conform to standard specified in the B.C. of India.

2. There should not be any court case or any completion from any corner in respect of the building plan No. 59/28 (Reg. No.) Subject to the completion of work by the applicant to this end are:-


- The construction of work should conform to the provisions of the Indian Building Code of Practice and all the conditions as proposed in the plan should be fulfilled.
- All building materials necessary for construction should conform to standard specified in the B.C. of India.
- Necessary steps should be taken for safety of lives of the adjoining public and private property during construction.
- Construction site should be maintained to prevent mosquito breeding.
- Design of all structural members including that of the foundation should conform to standard specified in the B.C. of India.

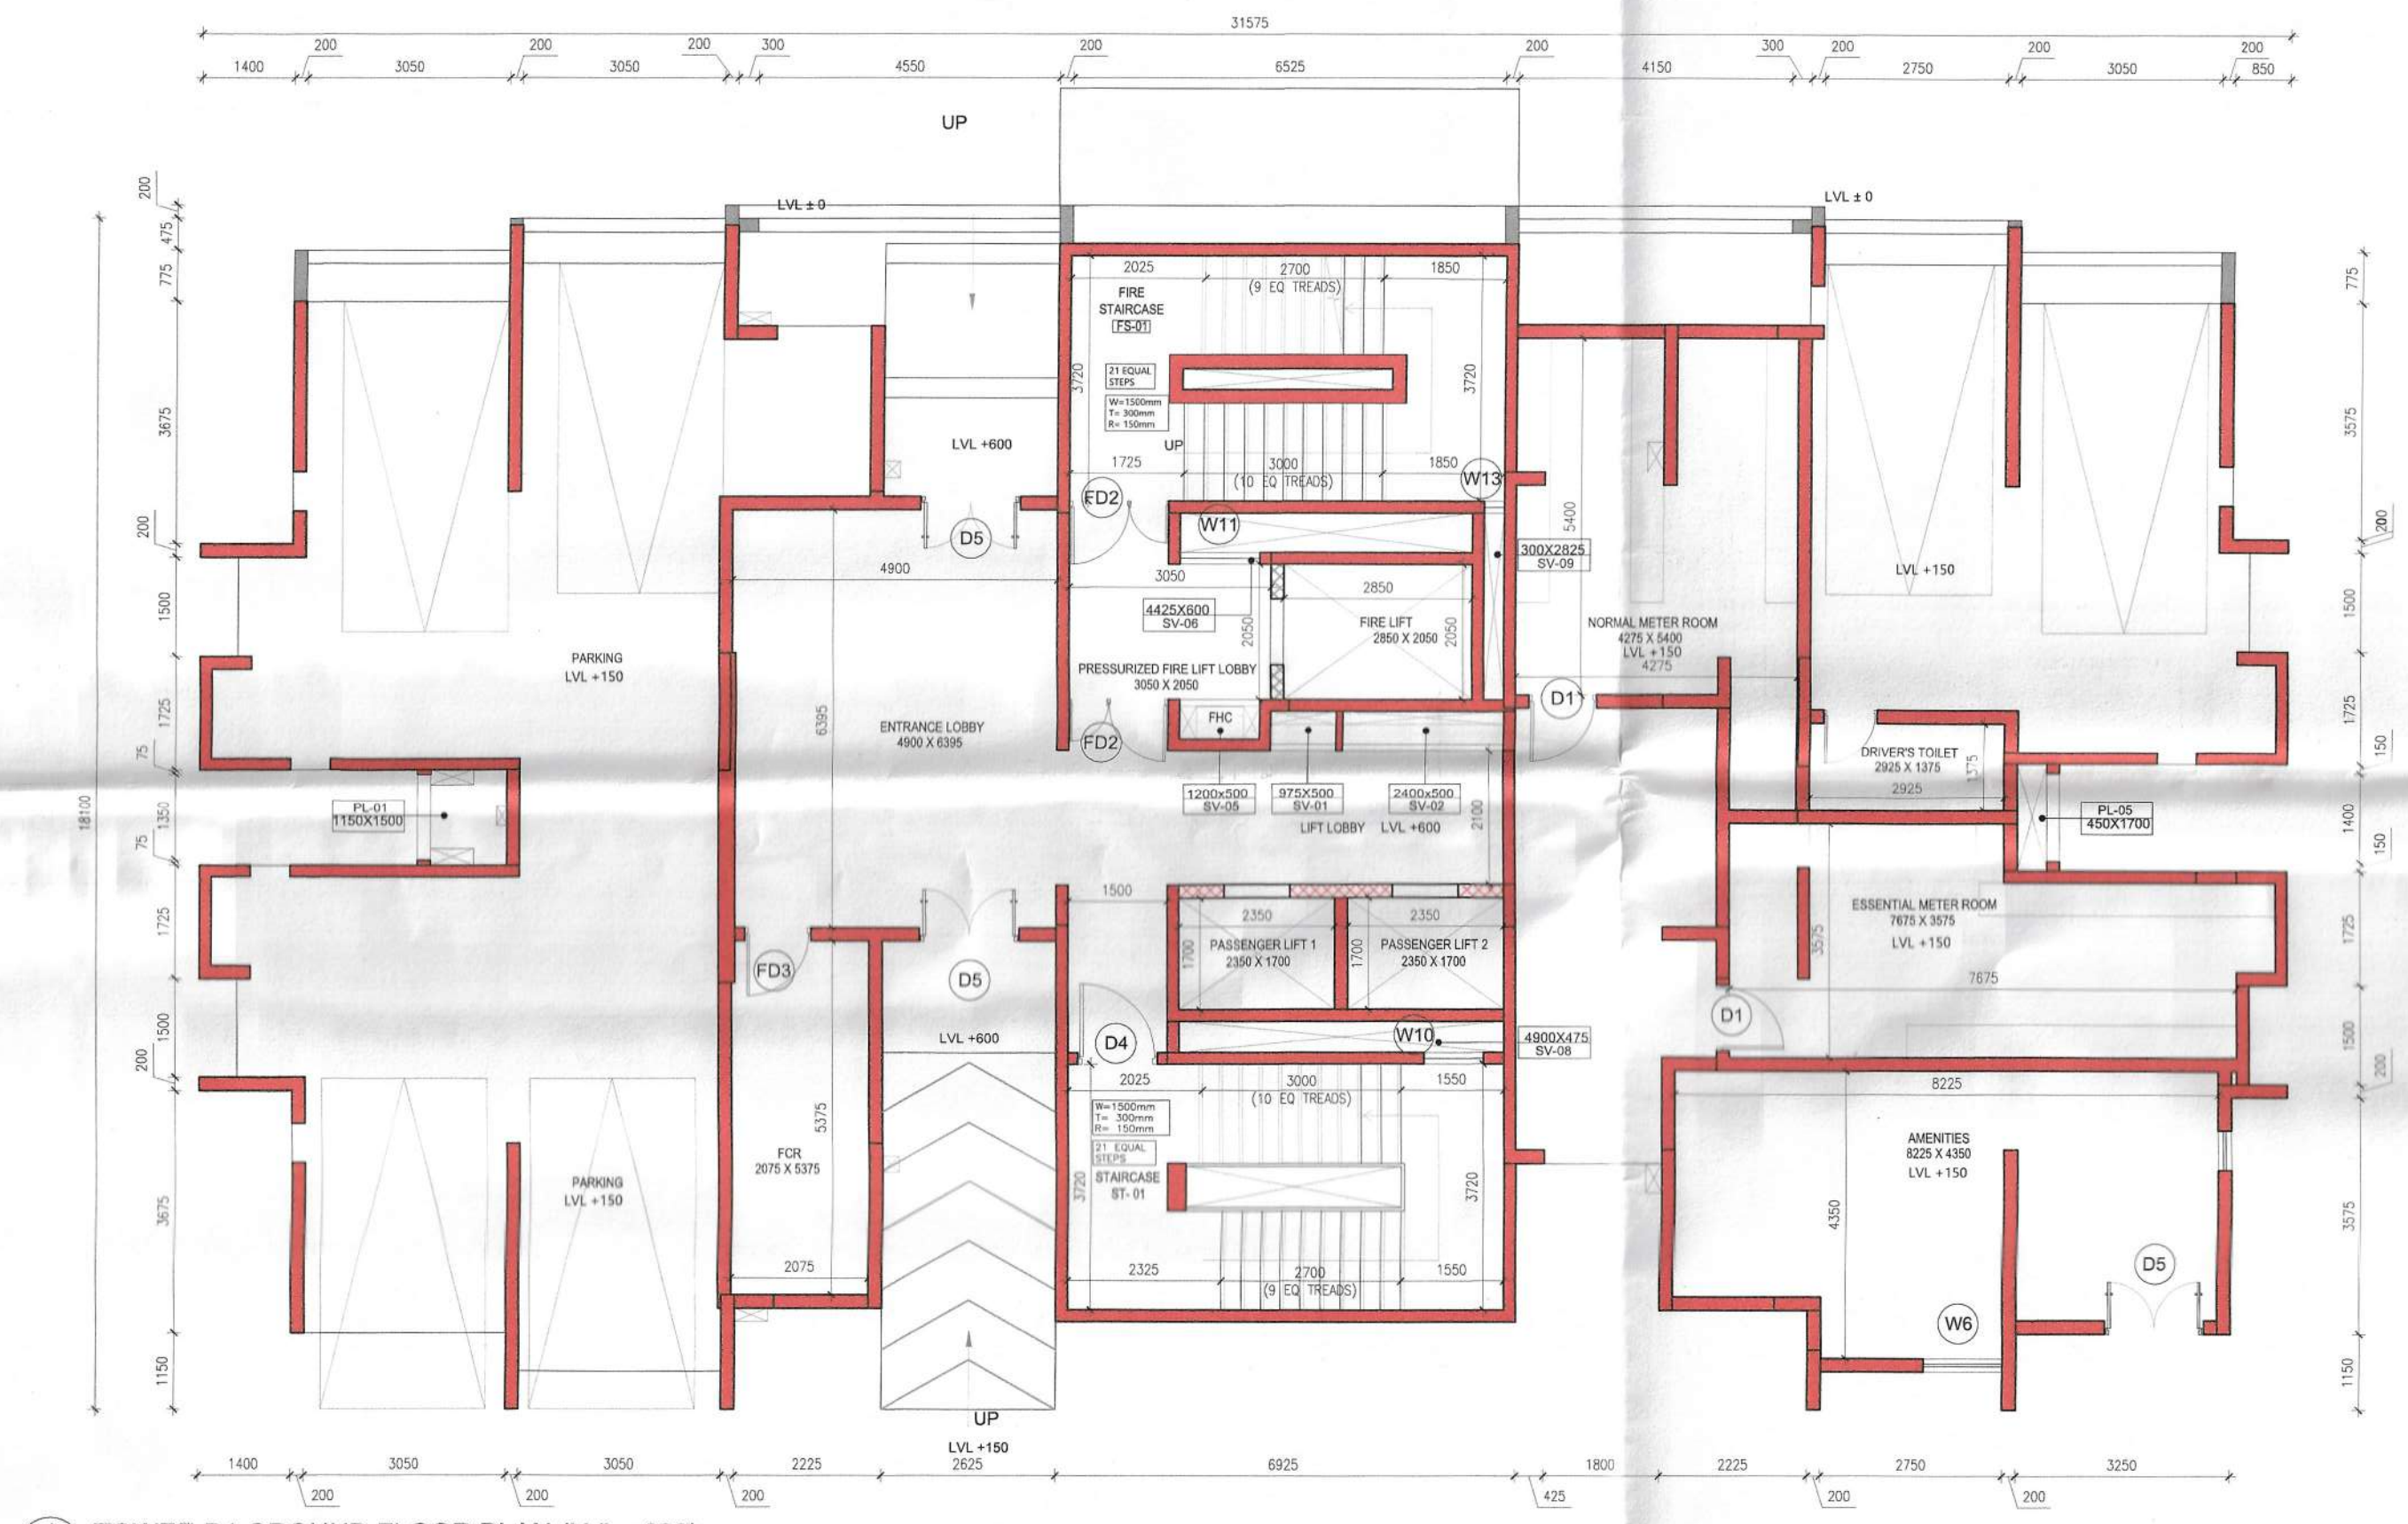


1 TOWER B1 GROUND FLOOR PLAN (LVL +600)
1:100

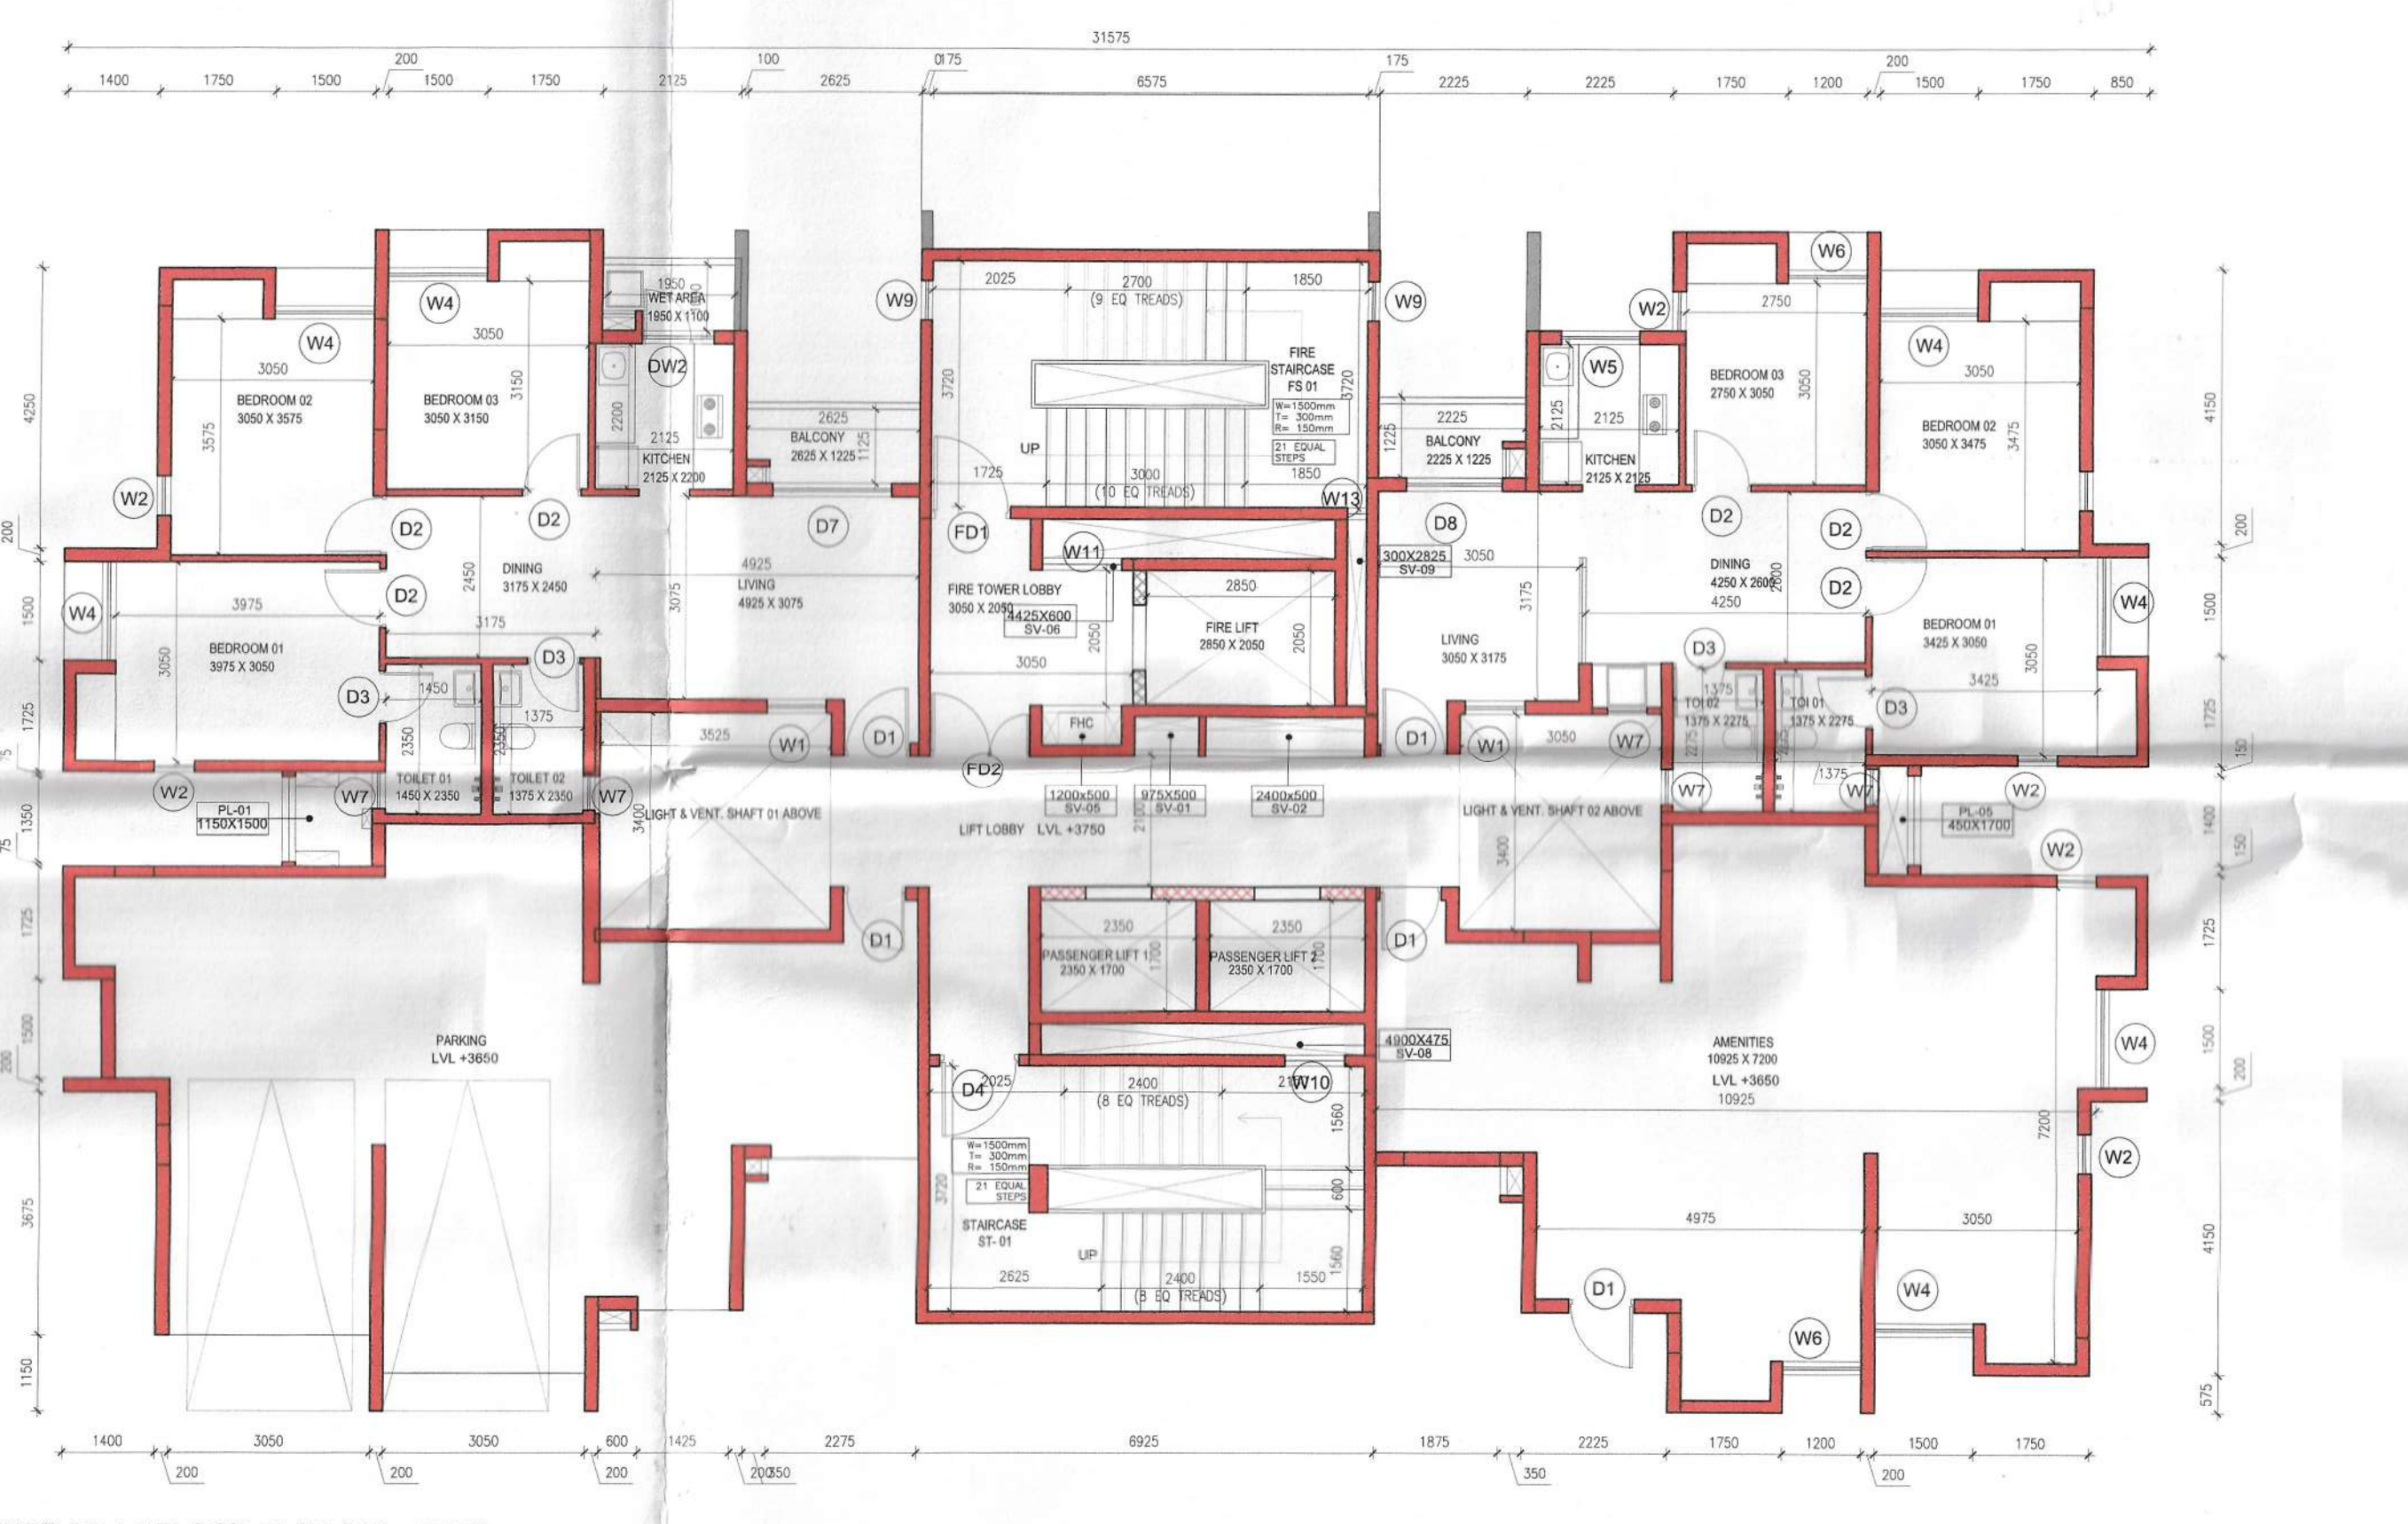

2 TOWER B1 1st FLOOR PLAN (LVL +3750)
1:100

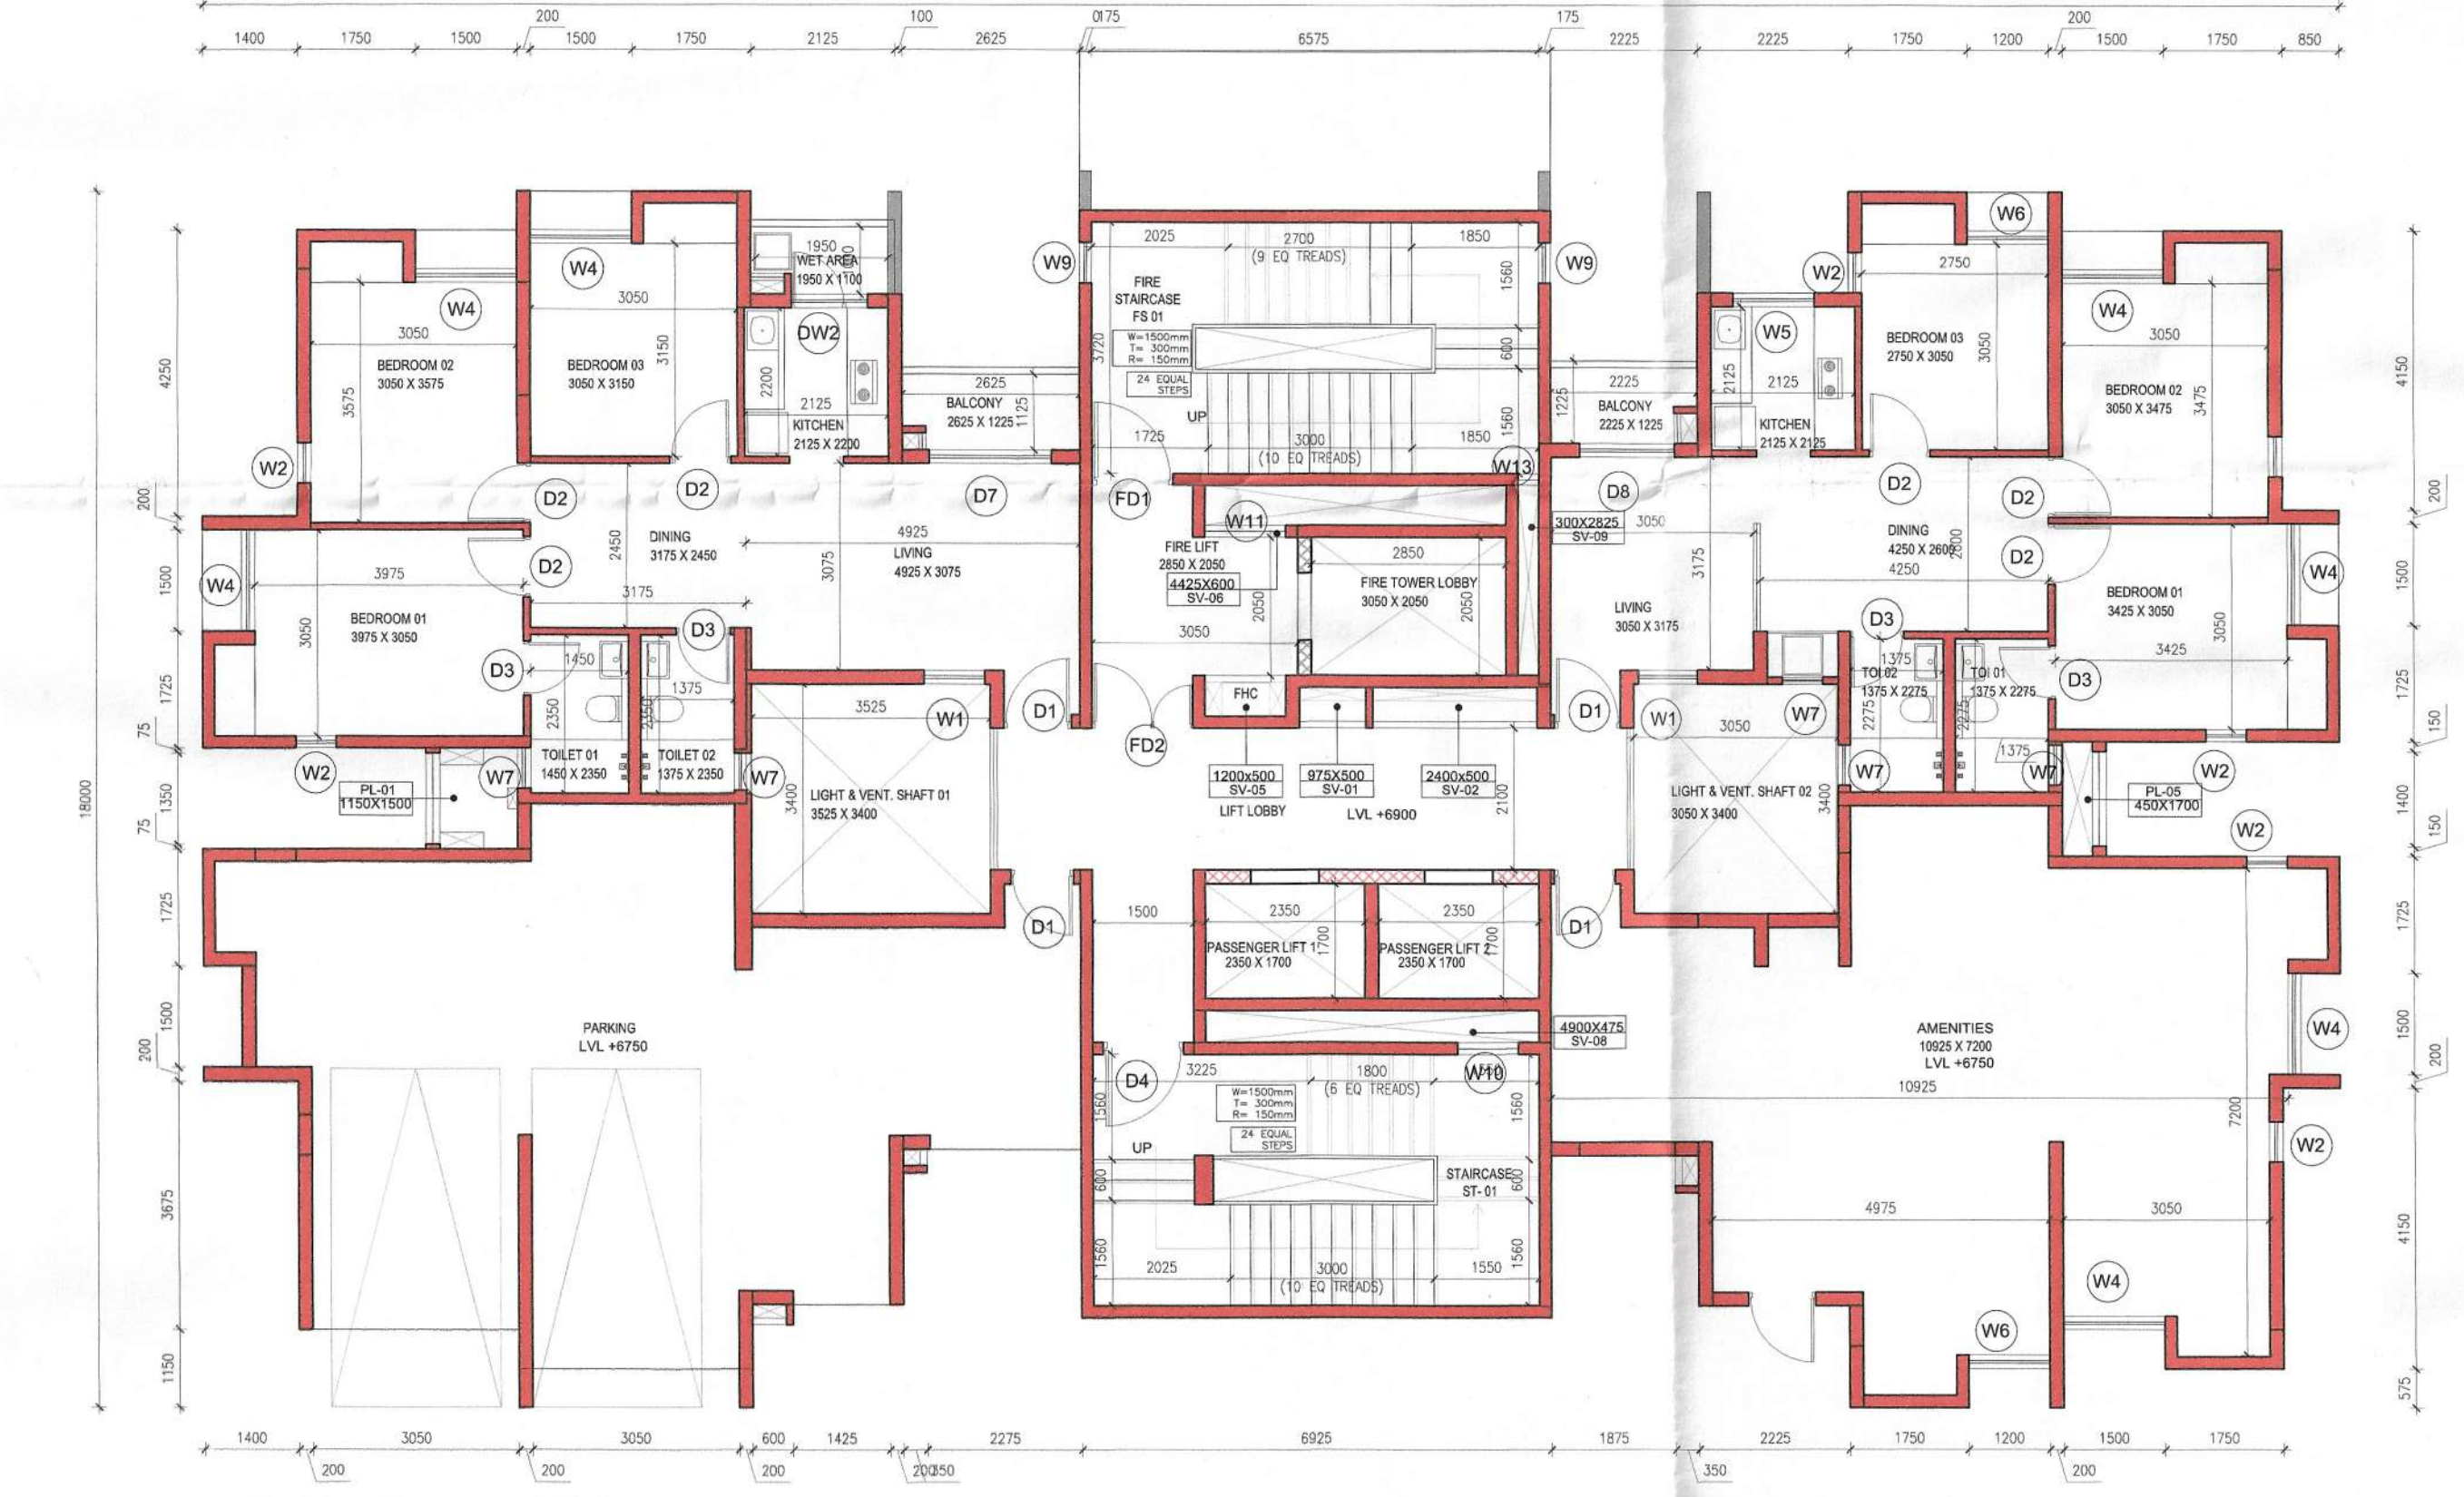


3 TOWER B1 2nd FLOOR PLAN (LVL +6900)
1:100

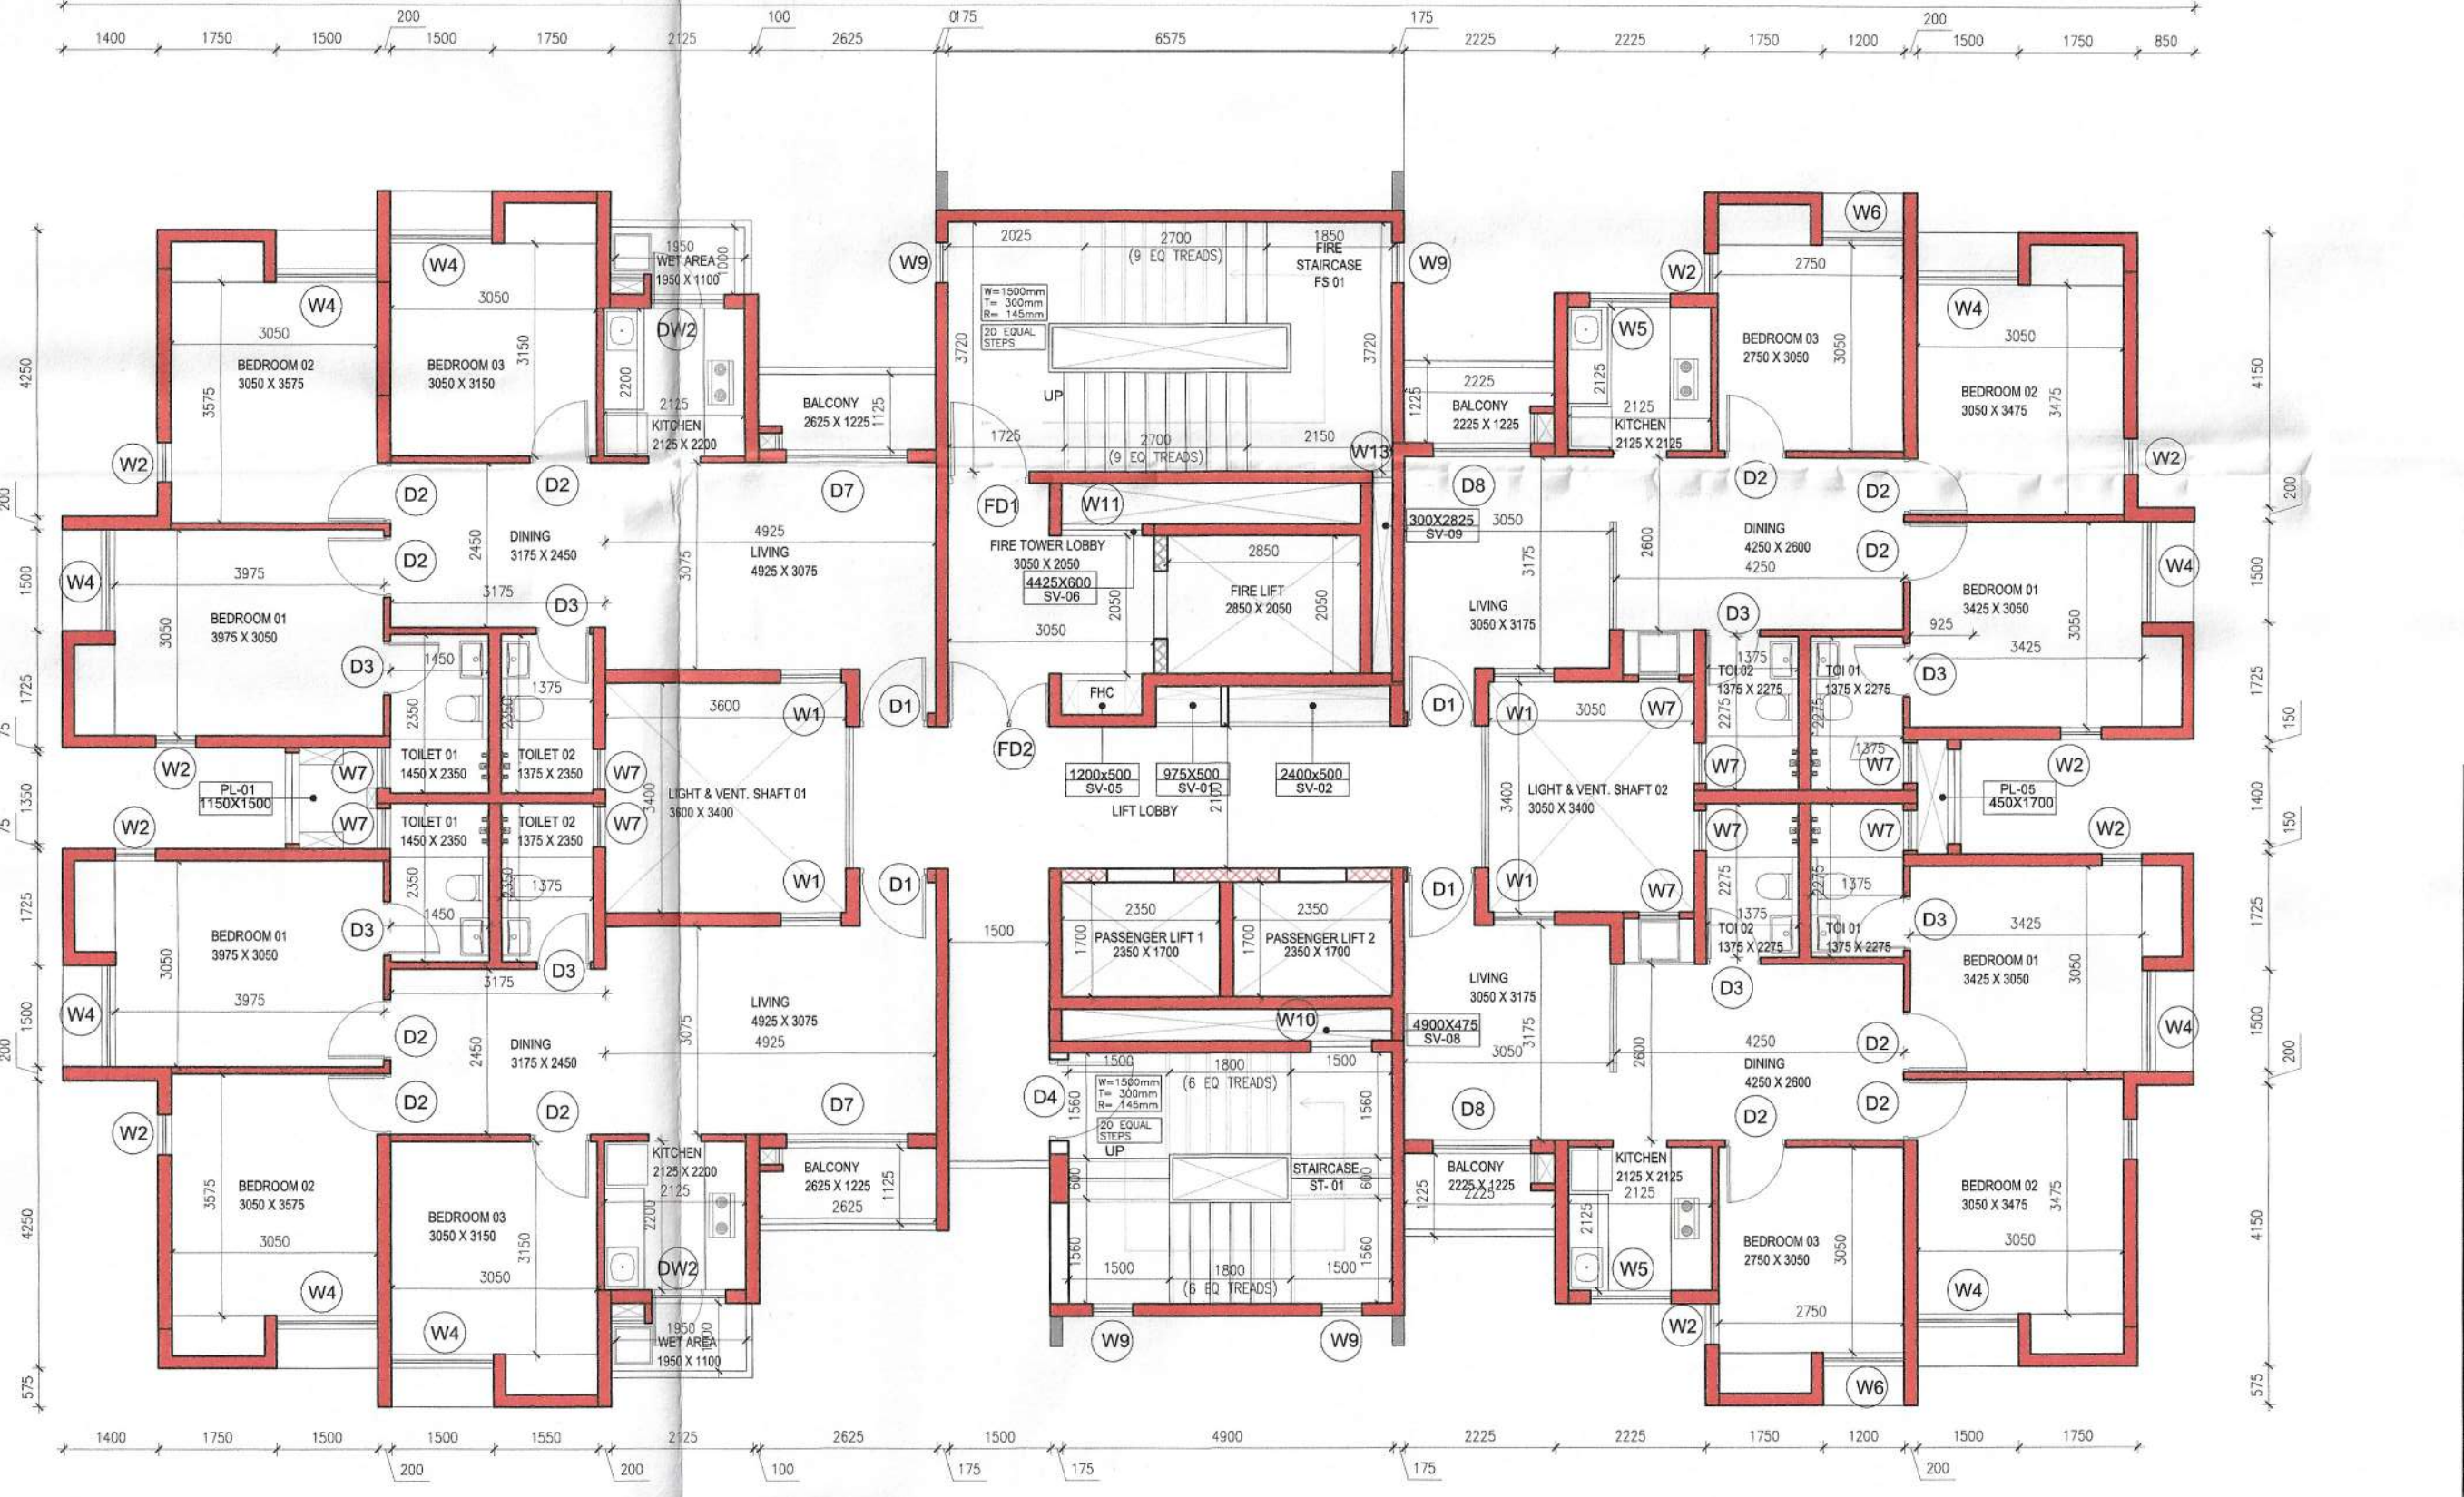

4 TOWER B1 TYPICAL FLOOR PLAN (3rd to 7th, 9th to 12th, 14th to 17th and 19th)
1:100

Signature of Architect
South 24 Pgs. 2.P.

- NOTES:**
- ALL DIMENSIONS ARE IN MM UNLESS IT IS MENTIONED.
 - FIRE-FIGHTING / SAFETY PROVISIONS WILL BE AS PER RELEVANT NBC PROVISIONS.
 - COVERING SLAB OF RESERVOIRS, FIRE TENDER PATH SHALL BE STRUCTURALLY SAFE FOR TAKING LOAD OF HEAVY VEHICLES LIKE FIRE TENDER.
 - ALL BUILDING WILL BE DESIGNED (STRUCTURES) AS PER RELEVANT I.S. CODES FOR EARTHQUAKE RESISTANCE.
 - PLEASE NOTE THAT THE DIMENSIONS IN THE DRAWINGS ARE TO BE READ, NOT MEASURED.

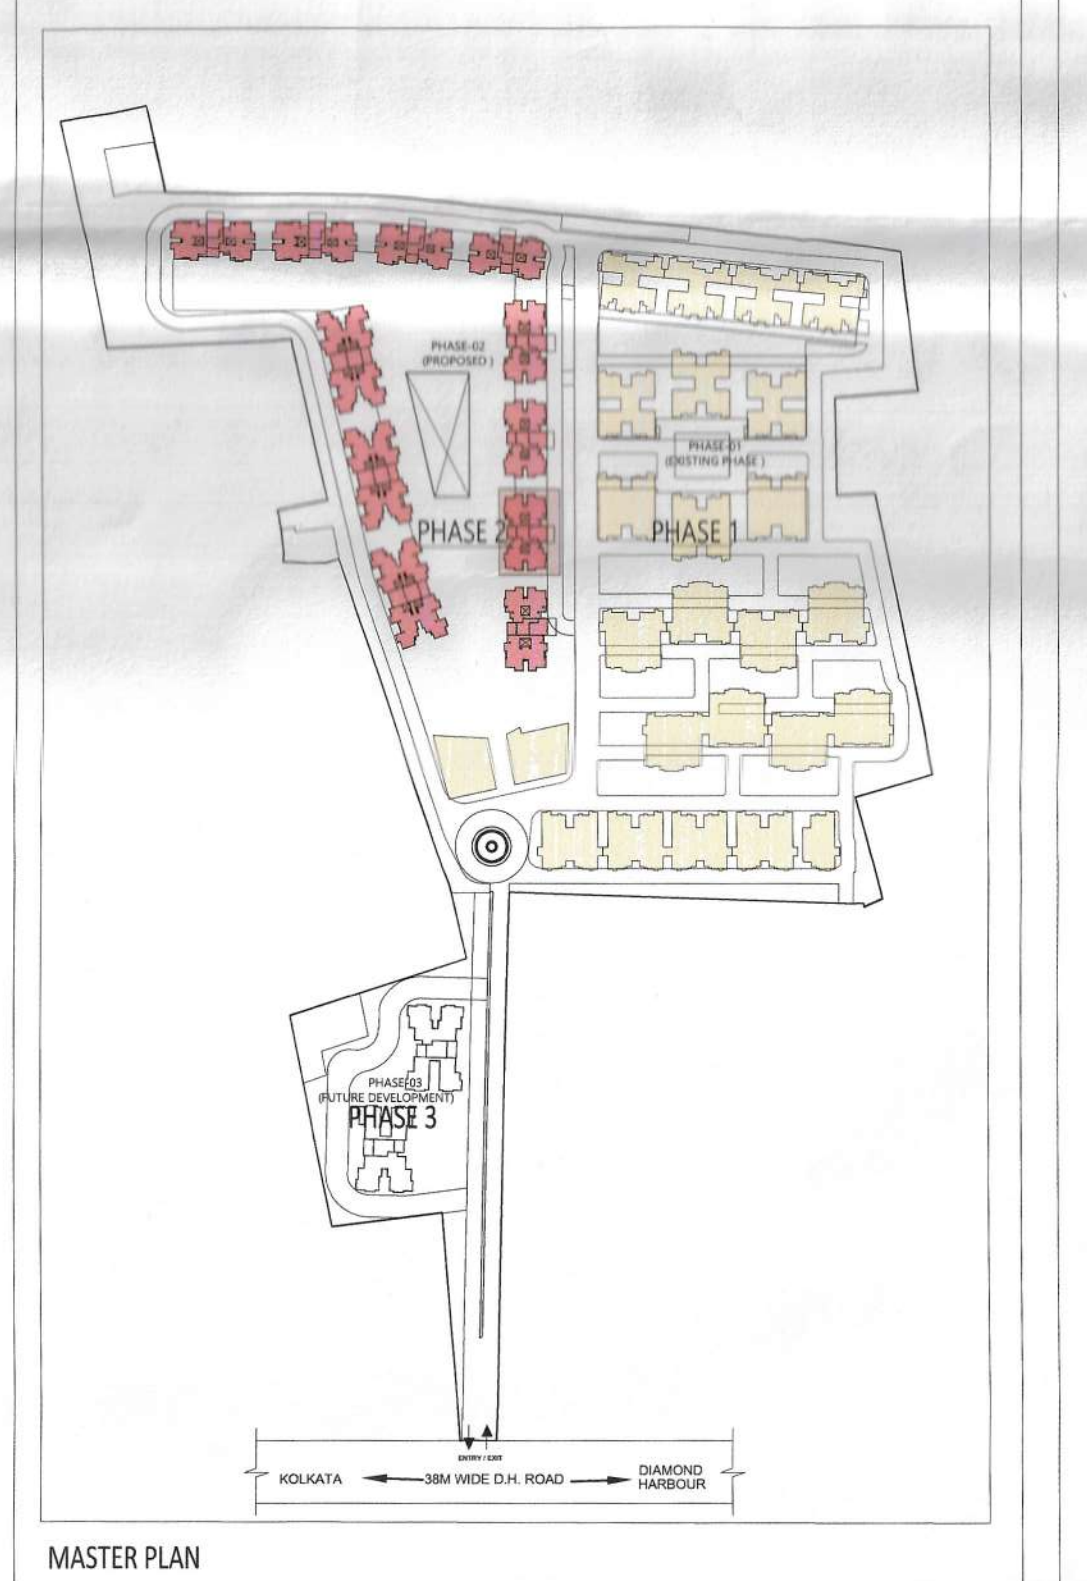

MASTER PLAN

GROUP HOUSING TOWERS A-D ALL FLOORS				
TYPE	Width (MM)	Height (MM)	Lintel (MM)	Sill (MM)
DOOR				
D1 Single Shutter Door	1000	2150	2150	0
D2 Single Shutter Door	900	2150	2150	0
D3 Single Shutter Door	800	2150	2150	0
D4 Single Shutter Door	1200	2150	2150	0
D5 Double Shutter Door	1500	2150	2150	0
D6 Sliding Door	2400	2150	2150	0
D7 Sliding Door	1800	2150	2150	0
D8 Sliding Door	1450	2150	2150	0
FIRE DOOR (2hrs. FIRE RATED)				
FD1 Single Shutter Door	1200	2150	2150	0
FD2 Double Shutter Door	1500	2150	2150	0
FD3 Single Shutter Door	1000	2150	2150	0
DOOR&WINDPW				
DW1 Single Shutter Door	800	2100	2100	0
Single Shutter Window	375	950	2150	1200
DW2 Single Shutter Door	800	2150	2150	0
Single Shutter Window	325	950	2150	1200
WINDOW				
W1 Double Shutter Window	900	1850	2150	300
W2 Single Shutter Window	600	1500	2150	650
W3 Triple Shutter Window	1800	1850	2150	300
W4 Triple Shutter Window	1500	1850	2150	300
W5 Double Shutter Window	1200	950	2150	1200
W6 Double Shutter Window	1200	1850	2150	300
W7 Top Hung Window	600	950	2150	1200
W8 Double Shutter Window	1350	1850	2150	300
W9 Fixed Window	600	1250	2150	900
W10 Louvered Window	900	1250	2150	900
W11 Louvered Window	1200	1250	2150	900
W12 Louvered Window	450	1250	2150	900
W13 Louvered Window	300	1250	2150	900
W14 Double Shutter Window	1200	1850	2150	300
W15 Double Shutter Window	1125	1850	2150	300

GROUP HOUSING TOWERS A-D ALL FLOORS				
Name	Length (MM)	Width (MM)	Type	Location
PL-01	1500	1150	Plumbing	Tower A,B
PL-02	1950	600	Plumbing	Tower A
PL-03	2900	375	Plumbing	Tower A
PL-04	1450	250	Plumbing	Tower C
PL-05	1700	450	Plumbing	Tower B
SV-01	975	500	Service	Tower A,B
SV-02	2400	500	Service	Tower A,B
SV-03	3750	425	Fire Lobby pressurization	Tower C
SV-04	1050	425	Staircase pressurization	Tower C
SV-05	1200	500	Fire	Tower A,B
SV-06	4425	600	Fire Lobby pressurization	Tower A,B
SV-07	2025	575	Service	Tower C
SV-08	4900	475	Staircase pressurization	Tower A,B,C
SV-09	300	2825	Staircase pressurization	Tower A,B

GROUP HOUSING TOWERS A-D ALL FLOORS				
TYPE	Width (MM)	Height (MM)	Lintel (MM)	Sill (MM)
FIRE DOOR (2hrs. FIRE RATED)				
FD1 Single Shutter Door	1200	2150	2150	0
FD2 Double Shutter Door	1500	2150	2150	0
FD3 Single Shutter Door	1000	2150	2150	0
DOOR&WINDPW				
DW1 Single Shutter Door	800	2100	2100	0
Single Shutter Window	375	950	2150	1200
DW2 Single Shutter Door	800	2150	2150	0
Single Shutter Window	325	950	2150	1200
WINDOW				
W1 Double Shutter Window	900	1850	2150	300
W2 Single Shutter Window	600	1500	2150	650
W3 Triple Shutter Window	1800	1850	2150	300
W4 Triple Shutter Window	1500	1850	2150	300
W5 Double Shutter Window	1200	950	2150	1200
W6 Double Shutter Window	1200	1850	2150	300
W7 Top Hung Window	600	950	2150	1200
W8 Double Shutter Window	1350	1850	2150	300
W9 Fixed Window	600	1250	2150	900
W10 Louvered Window	900	1250	2150	900
W11 Louvered Window	1200	1250	2150	900
W12 Louvered Window	450	1250	2150	900
W13 Louvered Window	300	1250	2150	900
W14 Double Shutter Window	1200	1850	2150	300
W15 Double Shutter Window	1125	1850	2150	300

GROUP HOUSING TOWERS A-D ALL FLOORS				
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PL-01	1500	1150	Plumbing	Tower A,B
PL-02	1950	600	Plumbing	Tower A
PL-03	2900	375	Plumbing	Tower A
PL-04	1450	250	Plumbing	Tower C
PL-05	1700	450	Plumbing	Tower B
SV-01	975	500	Service	Tower A,B
SV-02	2400	500	Service	Tower A,B
SV-03	3750	425	Fire Lobby pressurization	Tower C
SV-04	1050	425	Staircase pressurization	Tower C
SV-05	1200	500	Fire	Tower A,B
SV-06	4425	600	Fire Lobby pressurization	Tower A,B
SV-07	2025	575	Service	Tower C
SV-08	4900	475	Staircase pressurization	Tower A,B,C
SV-09	300	2825	Staircase pressurization	Tower A,B

DTC PROJECTS PVT. LTD.
SIGNATURE OF OWNER & SEAL
 DTC PROJECTS PVT. LTD.
 ADDRESS : 1 N.S ROAD, KOLKATA-700001

GEO TECHNICAL ENGINEER
 JISHU PAL
 B.Tech (Civil), M.E (Geo-tech)
 KMC Reg. No. G-7/1/32
 OTHER REGD. NO. 101643
 22/RJ30M/G-T-1/2016-17

THE STRUCTURAL DESIGN AND DRAWINGS OF BOTH FOUNDATION & SUPERSTRUCTURE OF THE BUILDING HAS BEEN MADE BY ME CONSIDERING ALL POSSIBLE LOADS INCLUDING THE SEISMIC LOAD AS PER THE NATIONAL BUILDING CODE OF INDIA AND CERTIFIED THAT IT IS SAFE AND STABLE IN ALL RESPECTS.

SIGNATURE OF STRUCTURAL ENGINEER & SEAL
 CIVIL AND STRUCTURAL CONSULTANT:
 M.N Consultants (Pvt) Ltd.
 ISO 9001:2008 CERTIFIED
 "M.N.C. HOUSE"
 1516,Rajdanga Main Road,
 Kolkata-700 107.
 Ph.no.-03334016-6700
 FAX NO. 2441-8083
 E-MAIL:mncnpl2008@gmail.com

THE PLOT HAS BEEN INSPECTED BY ME AND ON THAT BASIS I DO CERTIFY WITH FULL RESPONSIBILITY THAT THE PROPOSED BUILDING PLAN HAS BEEN DRAWN AS PER PROVISIONS OF BENGAL MUNICIPAL BUILDING RULE AS AMENDED FROM TIME TO TIME.

SIGNATURE OF ARCHITECT & SEAL
 Av. KETAN SUNIL HINGANIKAR | CA2006/37536
 ADDRESS : N 85B, Panchsheel Park, New Delhi 110017, India

PROJECT NAME: SOUTHERN HEIGHTS

DTC
 COMMIT DELIVER GROW

REVISED PLAN OF PROPOSED B+G+2P+17 RESIDENTIAL COMPLEX DTC SOUTHERN HEIGHTS AT JOKA DIAMOND HARBOUR ROAD P.O. - JOKA P.S.-BISHNUPUR MOUZA - DOULATPUR BLOCK- BISHNUPUR-I J.L. NO. - 79 DAG NO. - 11, 12, 13, 16, 17, 18, 19, 21, 24, 25, 26, 51, 52, 53, 54, 55, 56, 57, 58, 67, 87, 88, 89, 96, 97, 98, 99 MOUZA DAULATPUR, J No-79 UNDER KULERDARI GRAM PANCHAYET DIST.-24 PARGANAS(S)

SCALE: 1:100
 DATE: JUNE 2022
 TITLE: TOWER B1 FLOOR PLANS
 ORIENTATION: N

ARCHITECT
 morphogenesis
 N 85B, Panchsheel park,
 New Delhi 110017, India
 TEL: 91 11 41828070 FAX: 91 11 26490351
 E-Mail: studio@morphogenesis.org

DWG NO: 17
 BUILDING HEIGHT: G+2P+17